

TOWN OF ASHLAND BENTON COUNTY, MISSISSIPPI MUNICIPAL COMPLEX BUILDING



SHEET INDEX


	<u>OHEET INDEX</u>
T-0	TITLE PAGE
C-1	SITE PLAN
C-2	PLAN VIEW
C-3	ELEVATION VIEW
D-1	DETAILS

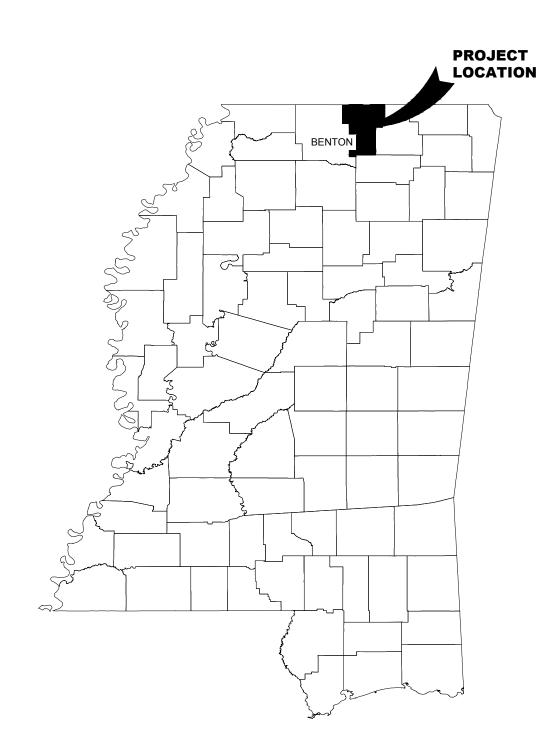

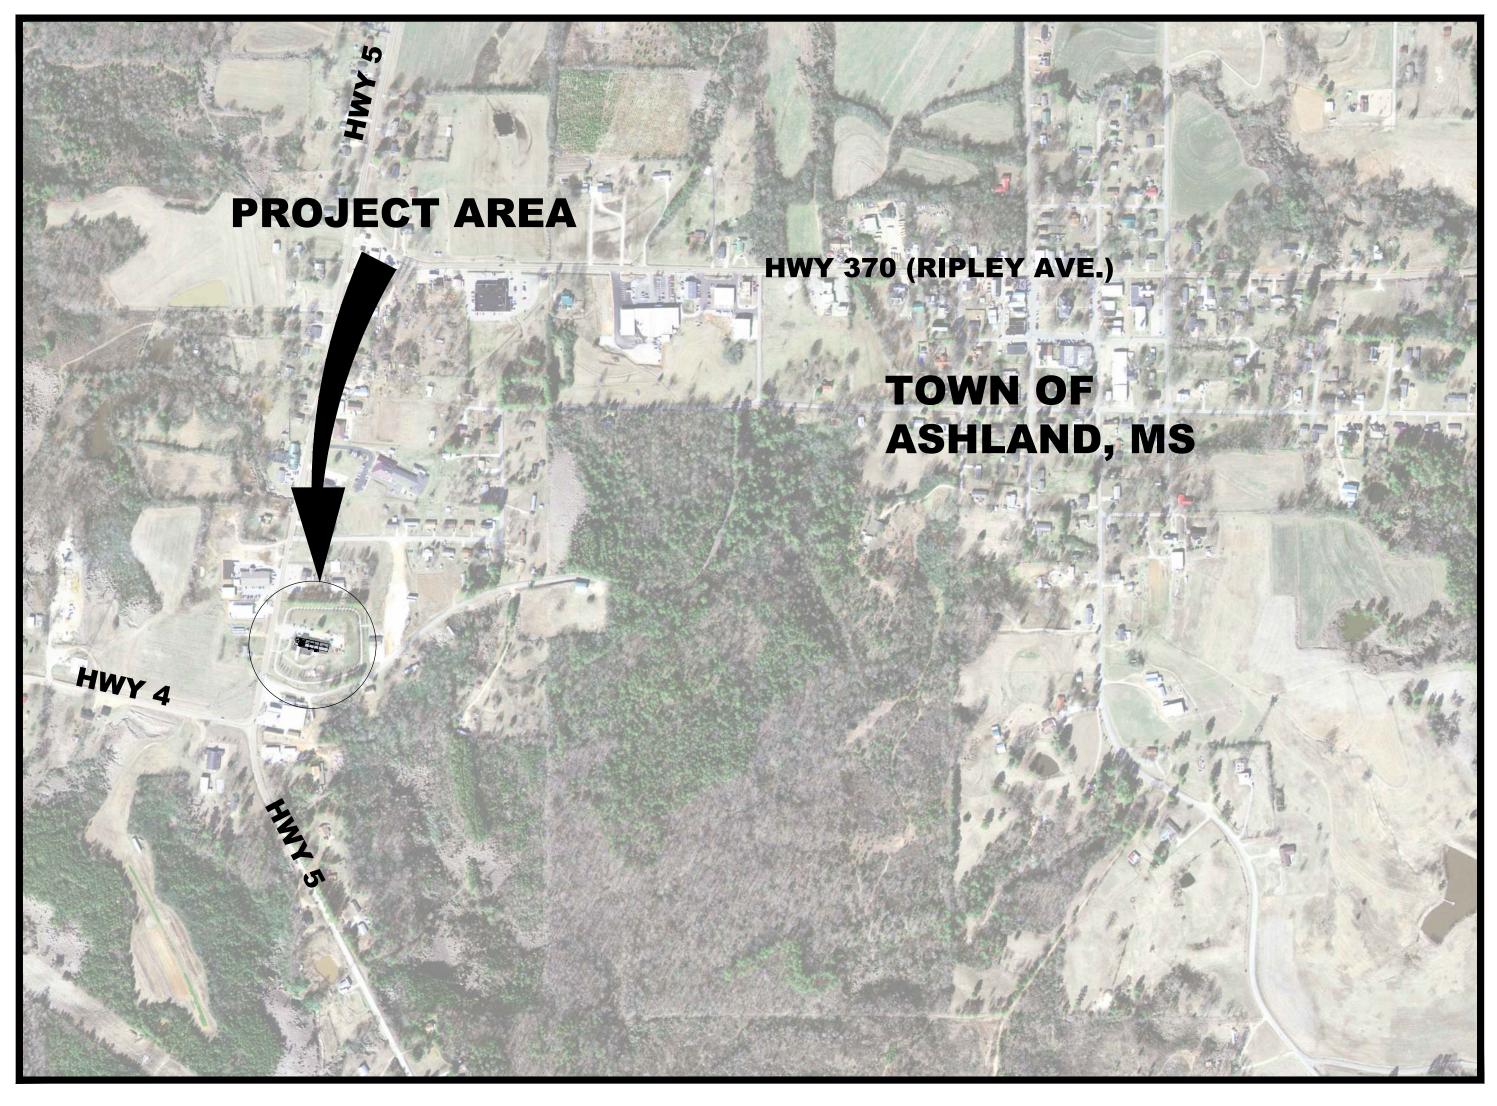

VICINITY MAP

1"=500

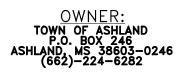

MUNICIPAL OFFICIALS

MAYOR

MITCH CARROLL

ALDERMAN

SANDRA GRESHAM, VICE-MAYOR MARK EHRIE BRIAN JEANS DON DANIEL GREG THOMPSON

> TOWN CLERK TRINA THOMPSON

TOWN ATTORNEY FARESE, FARESE AND FARESE, PA





S. MARK WARD
MS PE - 14249, MS PLS - 02850


<u>SCALE:</u> 1"=500' <u>ssue date:</u> ULY. 2021 3 07/06/202 \mathcal{O} Z $\sum_{i=1}^{n}$ \cap \square \geq P C L FA SIPI G AND MISSISS BUILDING OUNTY, N \bigcirc \square SHOI O m \square \mathbb{Z} \mathbb{Z} Z \triangleleft N $\sum \langle$ PROJECT NO ASH-21001 SHEET NO.


T-0

"REVIEW OF THESE PLANS IS LIMITED TO GENERAL COMPLIANCE WITH LOCAL CODES AND REGULATIONS AND DOES NOT WARRANT THE ENGINEER'S DESIGN OR RELIEVE THE CONTRACTOR OF ANY REQUIREMENTS, EVEN IF ERRORS, OMISSIONS, OR ANY INADEQUACIES ARE DISCOVERED AFTER PLAN APPROVAL. THE LOCAL CODES SHALL GOVERN, IF ANY CONFLICTS OCCUR WITH THE PLANS OR SPECIFICATIONS."

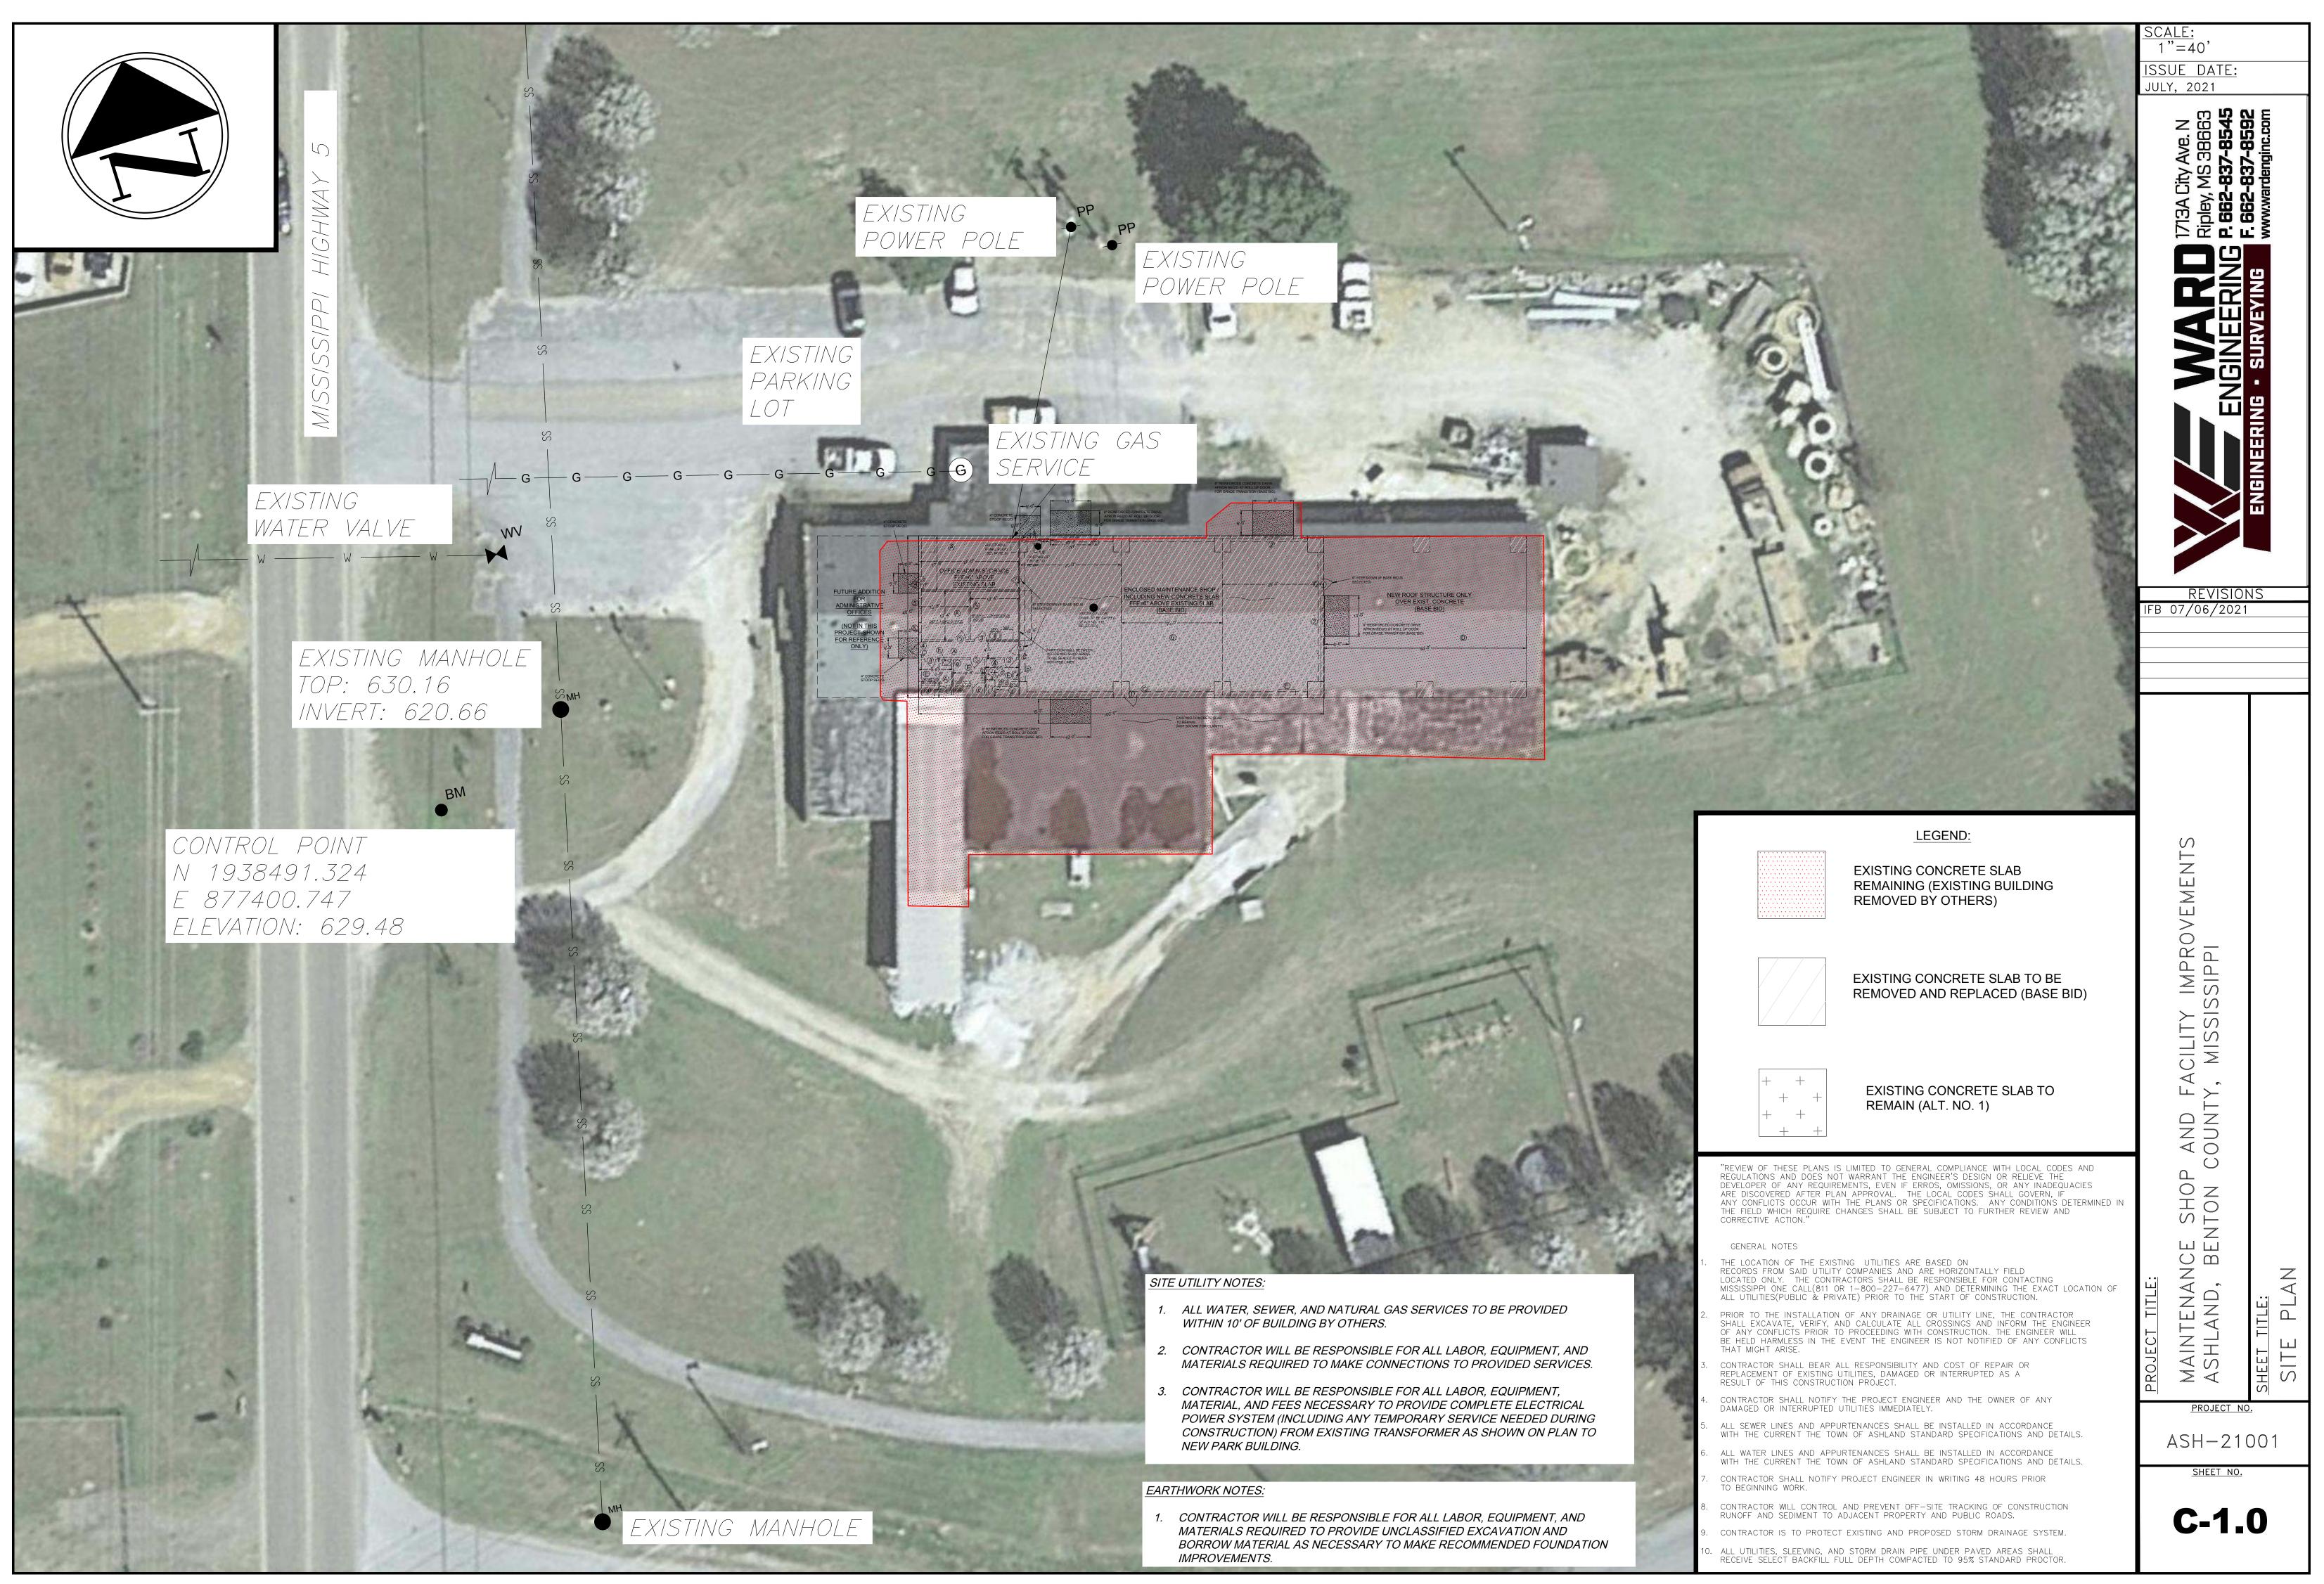

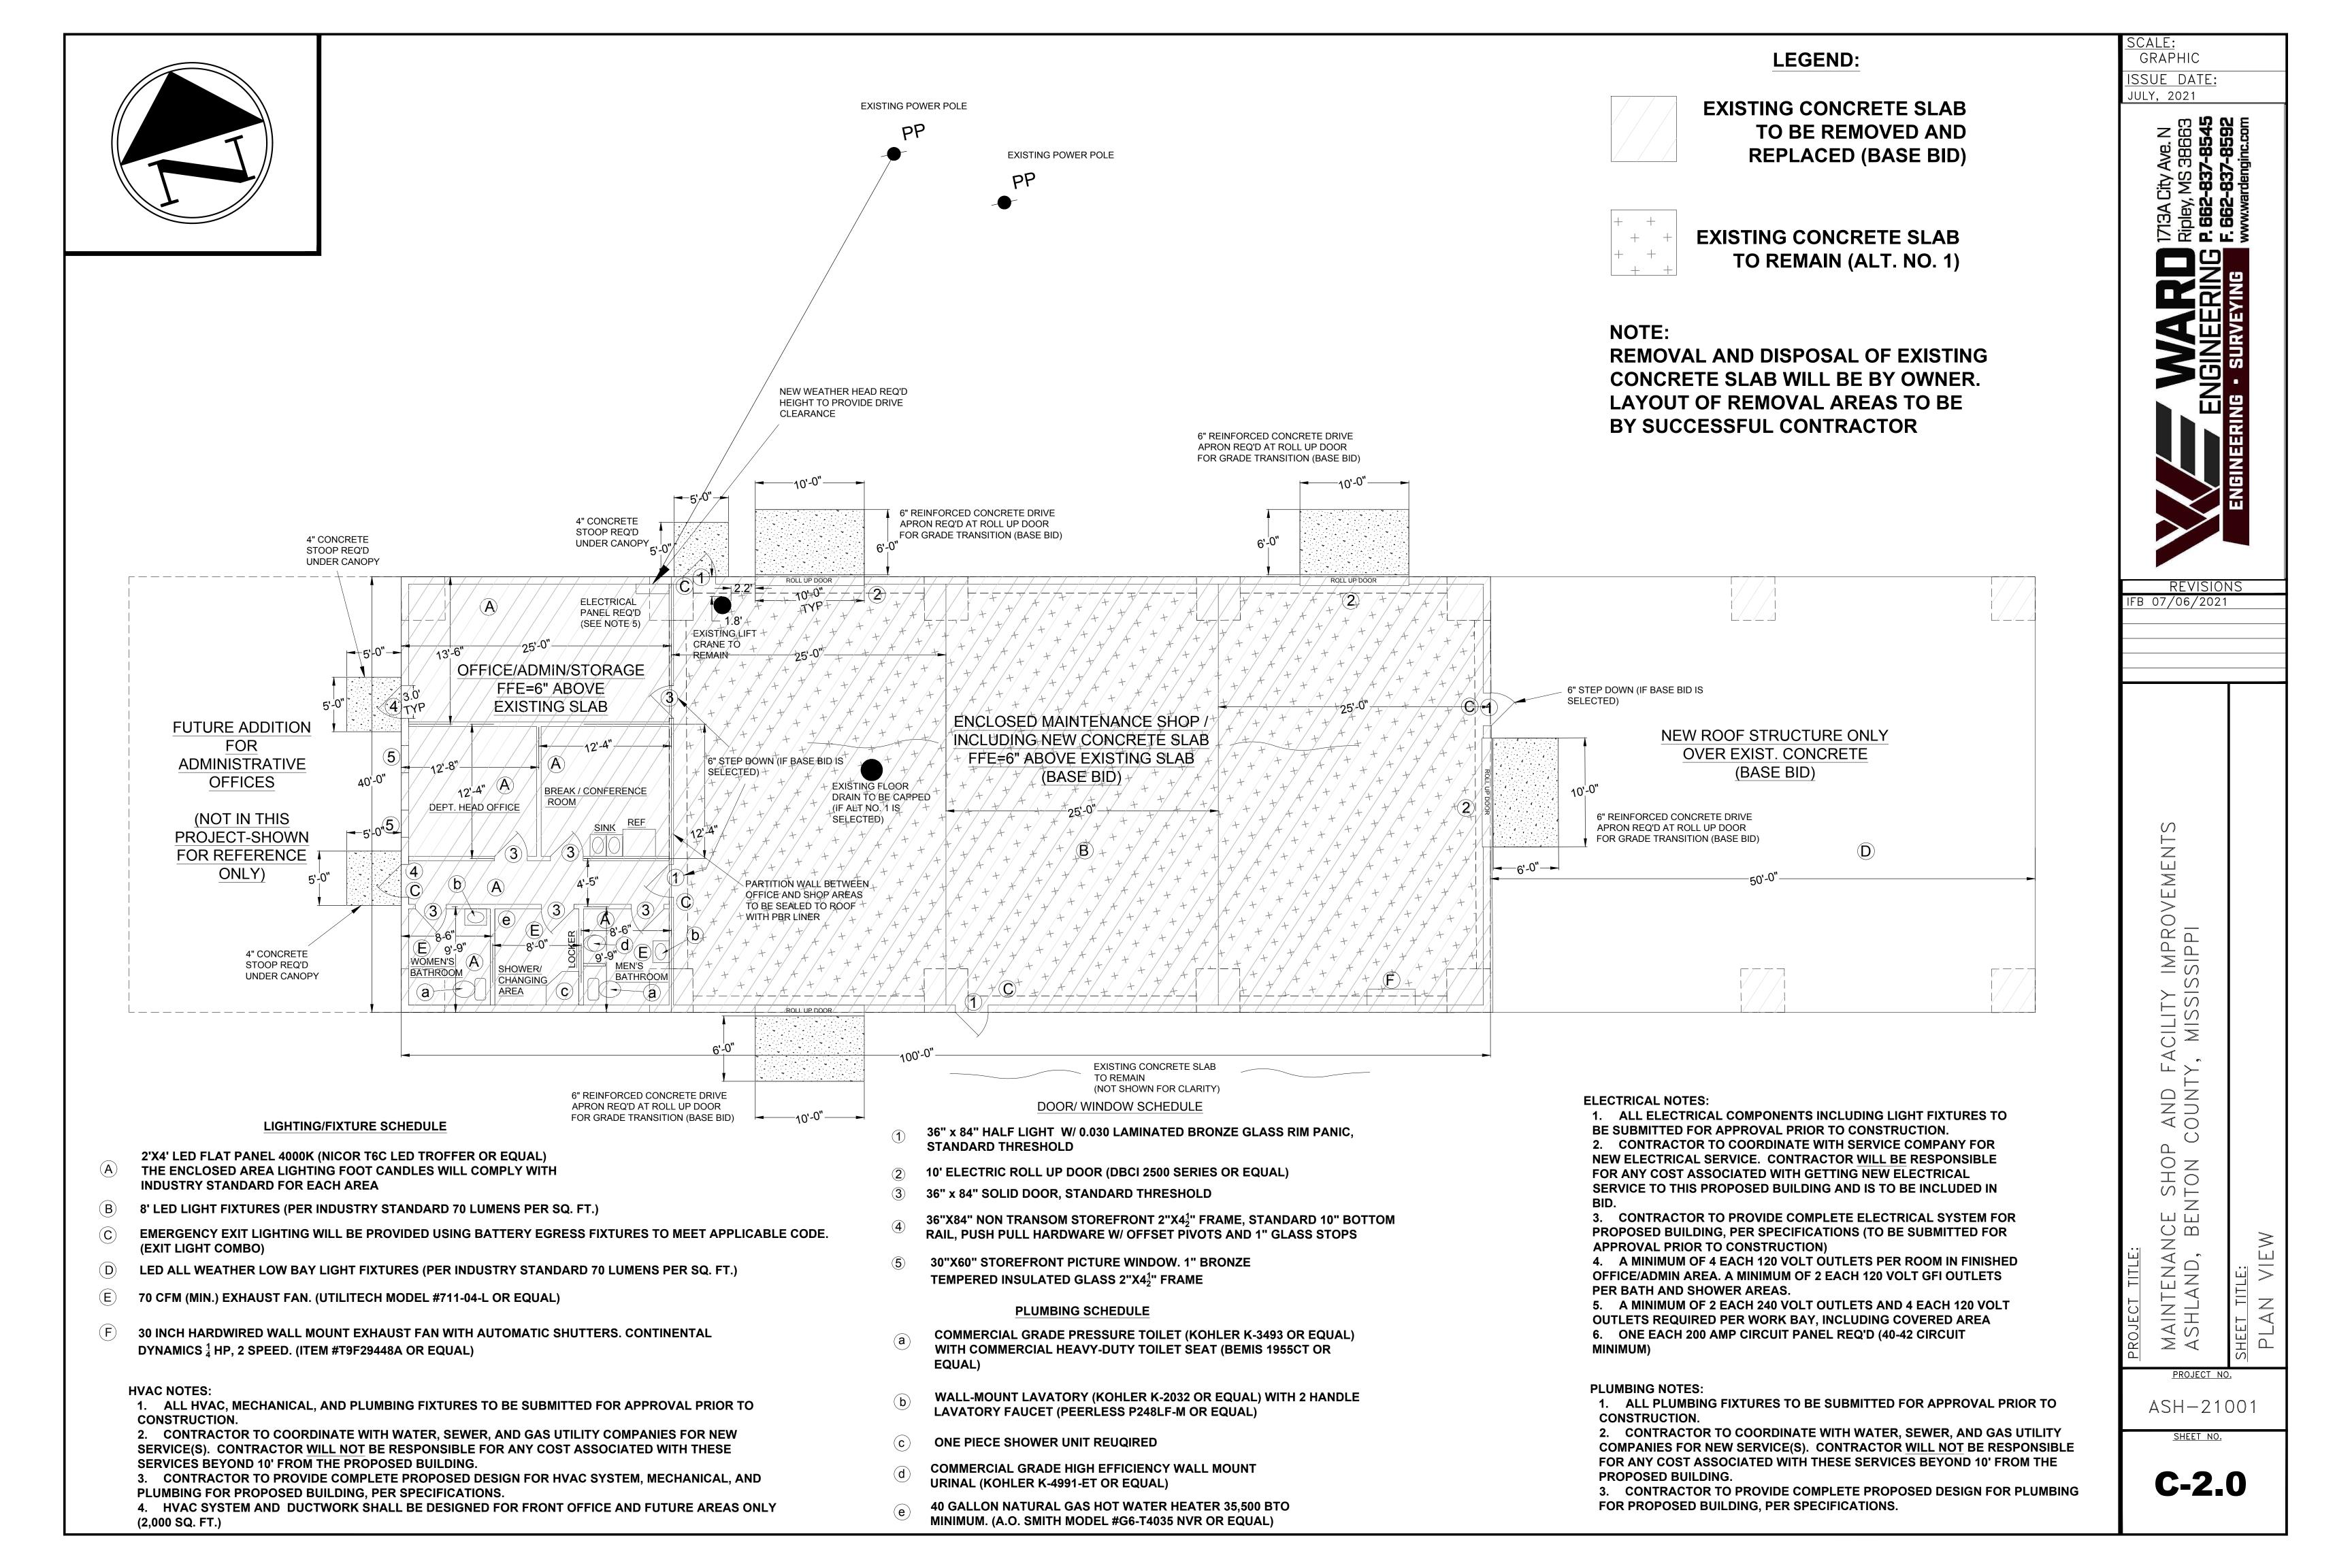

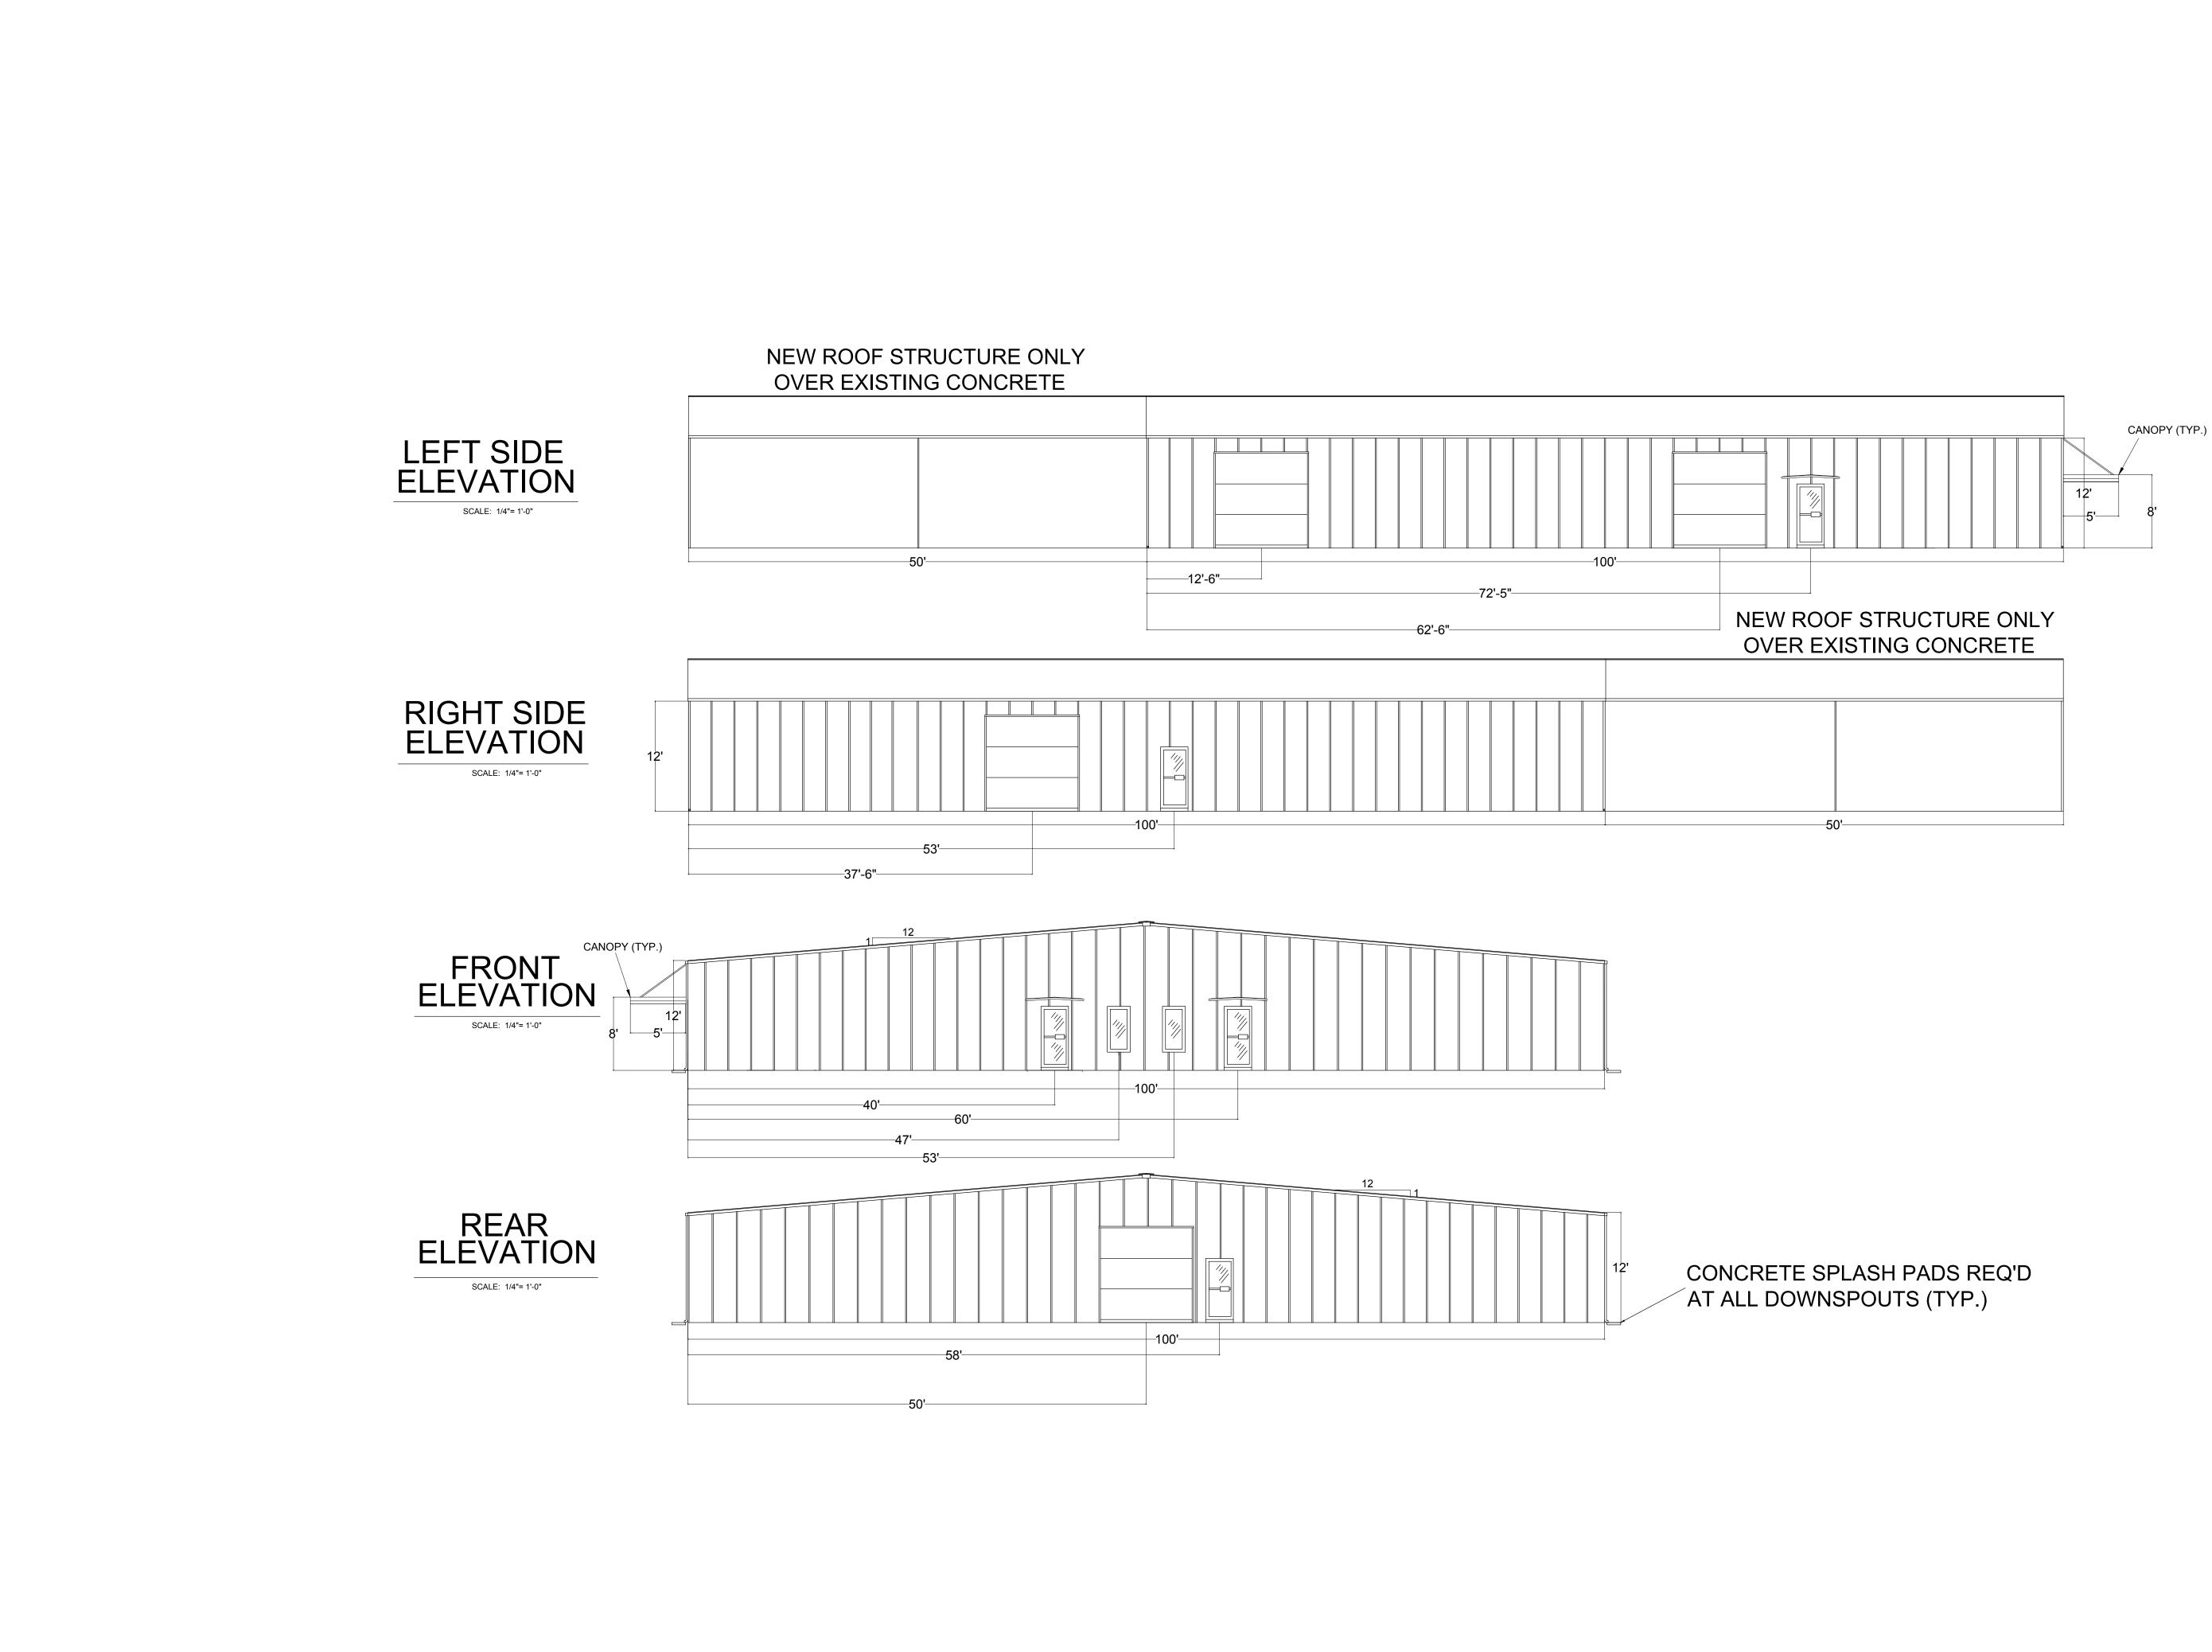

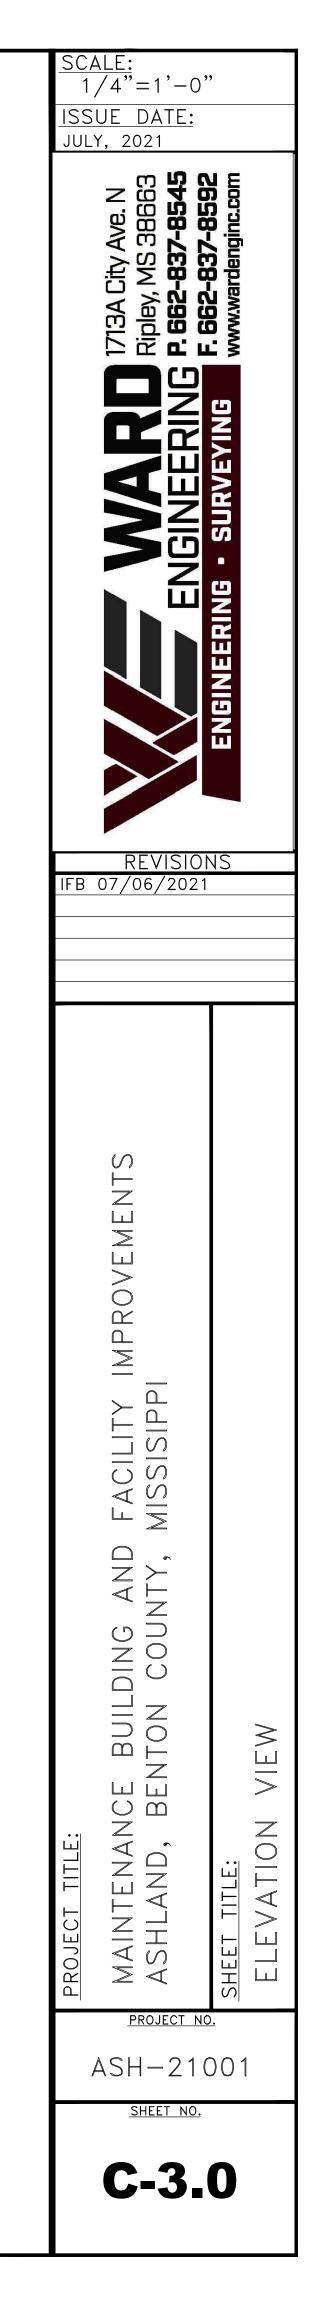

BUILDING NOTES:

1. THE PRE-ENGINEERED BUILDING IS TO BE DESIGNED IN ACCORDANCE WITH THE REQUIREMENTS OF THE 2015 EDITION OF THE INTERNATIONAL BUILDING CODE AND THE LATEST EDITION OF THE METAL BUILDING MANUFACTURES ASSOCIATION. ALL PLANS TO BE SEALED BY AN ENGINEER REGISTERED IN THE STATE OF MISSISSIPPI.

2. THE PRE-ENGINEERED BUILDING PACKAGE IS TO BE A COMPLETE DESIGN INCLUDING BUT NOT LIMITED TO, STRUCTURAL FRAMING BEAMS AND COLUMNS, HORIZONTAL WIND BEAMS, MISC. FRAMING BRACING, PURLINS, GIRTS, STEEL WALL AND ROOF PANELS, AND ANY FRAMING NEEDED TO SUPPORT ARCHITECTURAL COMPONENTS.

3. THE BUILDING AND SITE MUST BE BUILT TO MEET THE APPLICABLE REQUIREMENTS OF:

2015 INTERNATIONAL BUILDING CODE 2015 INTERNATIONAL EXISTING BUILDING CODE 2015 INTERNATIONAL FIRE CODE 2015 INTERNATIONAL FUEL GAS CODE 2015 INTERNATIONAL MECHANICAL CODE 2015 INTERNATIONAL PLUMBING CODE 2015 INTERNATIONAL RESIDENTIAL CODE

*THE CONTRACTOR IS RESPONSIBLE FOR MEETING ANY CITY, COUNTY, OR STATE SPECIFIC CODES THAT MAY BE UPDATED FROM THE MINIMUM REQUIREMENTS OF THE 2015 INTERNATIONAL CODES.

4. BUILDING EXTERIOR COLOR(S) COORDINATED WITH OWNER SELECTION

5. THE INTERIOR WALLS IN OFFICE/BATHROOM/ADMIN AREAS SHALL BE CONSTRUCTED USING EITHER WOOD STUDS OR METAL STUDS WITH $\frac{1}{2}$ " DRYWALL FINISH.

6. ALL ROOMS SHALL HAVE AN 8' SUSPENDED CEILING, INTERIOR WALLS, FLOOR TRIM, AND INSULATION THROUGHOUT. BATH WALLS SHALL RECEIVE 1/2" WET-DRY GYPSUM BOARD FINISHED AND PAINTED. CEILING SHALL BE SUSPENDED ACOUSTICAL.

7. ALL OFFICE AREA FLOOR COVERINGS SHALL BE VCT TILE OR PAINTED CONCRETE UNLESS NOTED OTHERWISE. CONCRETE FLOOR PAINT COLOR SHALL BE COORDINATED WITH THE OWNER. CONTRACTOR SHALL PRESENT THE COST ALLOWANCE TO THE OWNER TO LEAVE CONCRETE NATURAL FINISH

8. BATHROOM VANITIES SHALL BE SOLID WOOD CONSTRUCTION AND CORRESPOND WITH THE LAYOUT SHOWN ON THIS SHEET WITH FORMICA COUNTER TOPS.

9. ALL DOORS SHALL INCLUDE HARDWARE. CONTRACTOR SHALL COORDINATE STYLE/FINISH WITH OWNER. ALL STEEL DOORS SHALL HAVE CLOSERS INSTALLED.

10. ALL EXTERIOR & INTERIOR DOORS ARE TO BE HOLLOW CORE METAL, UNLESS NOTED OTHERWISE. EXTERIOR DOORS SHALL HAVE LOCKING DEAD BOLT AND KNOB. ALL EXTERIOR DOORS SHALL BE KEYED ALIKE.

11. ALL EXTERIOR WALLS AND ROOF TO HAVE 4" WMP-VR INSULATION INSTALLED.

12. RESTROOMS TO MEET CURRENT ADA STANDARDS.

13. HVAC DUCTWORK AND EFFLUENT PIPING NOT SHOWN FOR CLARITY. CONTRACTOR SHALL PROVIDE A COMPLETE DESIGN OF MECHANICAL SYSTEM INCLUDING HVAC PER SPECIFICATIONS FOR APPROVAL PRIOR TO CONSTRUCTION. ALL REFERENCES TO THE QUANTITY AND SIZE FOR MECHANICAL COMPONENTS IN THE CONTRACT DOCUMENTS AND PLANS ARE MINIMUM REQUIREMENTS AND SHALL BE DESIGNED AS REQUIRED TO PROVIDE OCCUPANT COMFORT, ENERGY EFFICIENCY AND FUTURE FLEXIBILITY FOR FINAL DESIGN. (2,000 SQ. FT. MINIMUM)

CONCRETE SLAB

